Bid Date: May 29, 2024 4:00 p.m. CDT

TO ALL BIDDERS: Renovations of the Library on the Kemper Campus Boonslick Regional Library – Cooper County Branch

THIS ADDENDUM SHALL SUPERSEDE THE PLANS AND SPECIFICATIONS INSOFAR AS IT IS IN DISAGREEMENT WITH THE SAME. HOWEVER, IT WILL IN NO WAY RELIEVE THE CONTRACTOR OF ANY RESPONSIBILITY UNDER THE PLANS AND SPECIFICATIONS, EXCEPT AS HEREIN SPECIFICALLY STATED.

All Addenda's will be provided via e-mail to all Plan Rooms and any General Contractors on the Plan Holders List. All other Contractors and Vendors to obtain a copy of the Addenda's from one of the above.

#### **Architectural Items:**

Item No. A01 – CLARIFICATION – Drawings, Existing Doors

1) Existing Doors 101 and 102 are to be re-painted.

Item No. A02 – CHANGE – Existing Exterior Stair

- 1) Existing exterior stair (all components) to be sandblasted, primed and painted.
- 2) See paint specification for exterior primer and paint.

Item No. A03 – ADDITIONAL – Fire Alarm System

1) Existing Fire Alarm Panel is model Notifier SFP-10UD.

Item No. A04 – CLARIFICATION – Counter Top material

1) All counter tops are to be Quartz. There are NO p-lam counters. This is to include all restroom lavatories. Quartz to be MSI Calacatta Ultra or equal.

Item No. A05 – CLARIFICATION – Exterior Building Painting

- 1) All existing metal and wood at main entrance, at cornice and parapet caps and trims, circle windows, etc. are to be cleaned and painted. This is to include the areas on the North, South and east sides. See areas clouded on sheet A301.
- 2) Work is to include scraping and repairing existing surfaces as required to achieve smooth, paintable surfaces.

Item No. A06 – CLARIFICATION – Room Storage 019

1) Storage-019 - All walls are to be finished with gyp. bd. and painted. Ceiling is to be open to bottom of stair and unpainted.

**Structural Items:** None this Addendum

#### **MEP Items:**

Item No. MEP1 – CHANGE – RE-ISSUE ALL PLUMBING SHEETS

P101: Lower Level Plumbing Demolition Plan:

1) Additional notes have been added and / or modified.

P102: Main Level Plumbing Demolition Plan:

1) Additional notes have been added and / or modified.

P103: Lower Level Plumbing Renovation Plan:

1) Additional notes have been added and / or modified.

P104: Main Level Plumbing Renovation Plan:

1) Additional notes have been added and / or modified.

P105: Upper Level Plumbing Renovation Plan:

1) Additional notes have been added and / or modified.

P601: Plumbing Schedules and Details:

- 1) Two isometric details are added for the Main Level sink S-1 drain, and modifications to the domestic water system for two sinks, the addition of a new backflow preventer, and the addition of an expansion tank.
- 2) An expansion tank schedule was added.

**Approved Substitution Requests:** None this Addendum

**Attachments:** Re-Issue Plumbing Sheets: 6 full size sheets

Current GC Plan holder List: 1 page

## KEYED PLUMBING DEMOLITION NOTES

- SAW CUT CONCRETE FLOOR AS REQUIRED TO INSTALL 3" DRAIN FOR NEW SINK S-2 AS SHOWN ON THE LOWER LEVEL PLUMBING RENOVATION PLAN, SHEET P103.
- (2) REMOVE PART OF THE ABOVE GRADE DOMESTIC WATER ENTRANCE PIPING AS REQUIRED TO INSTALL A NEW BACKFLOW PREVENTER. SEE SHEET P601, DETAIL 7.
- (3) REMOVE EXISTING WALL HUNG STAINLESS STEEL SINK, EXPOSED DRAIN, AND WATER SUPPLIES INCLUDING EXISTING STOPS. EXISTING SINK DRAIN AND IN-WALL WATER SUPPLY PIPING IS TO REMAIN. NEW DRAIN PIPING AND WATER STOPS/SUPPLIES ARE TO BE PROVIDED FOR NEW SINK AT THIS LOCATION.
- (4) saw cut existing concrete floor, and remove part of the sheet rock wall as required to install new 2". DRAIN PIPE FROM MAIN LEVEL SINK, AND TO TIE INTO EXISTING 3" SUBGRADE BUILDING DRAIN. SEE SHEET P601, DETAIL 6.
- (5) REMOVE EXISTING HOT AND COLD WATER SUPPLY PIPES UP THROUGH THE CEILING DECK TO THE MAIN LEVEL. CAP WATER BRANCHS IN LOWER LEVEL CEILING. REMOVE EXISTING 2" DRAIN DOWN TO HORIZONTAL DRAIN IN LOWER LEVEL CEILING SPACE AND CAP.
- (6) REMOVE EXISTING VENT STACK UP THROUGH FLOOR. VENT IS BEING RELOCATED SLIGHTLY TO THE NORTH AS INDICATED ON LOWER LEVEL AND MAIN LEVEL PLUMBING RENOVATION PLANS.
- (7) THIS WC LOCATION WILL HAVE A NEW CHILD'S WC INSTALLED. REVISE DRAIN TOILET FLANGE LOCATION AND 3" DRAIN BRANCH AS REQUIRED TO MATCH THE NEW WC ROUGH-IN.
- (8) REMOVE DRAIN PIPE SECTION FOR THE INSTALLATION OF NEW 3" VERTICAL DRAIN STACK. NEW STACK WILL SERVE THE UPPER LEVEL RESTROOM.
- (9) EXISTING FLOOR DRAIN TO REMAIN.
- (10) EXISTING DRAIN AND WATER SUPPLIES UP TO MAIN LEVEL TO REMAIN FOR NEW LAVATORY

- (11) EXISTING DRAIN UP THROUGH FLOOR TO LAVATORY ON MAIN LEVEL.
- (12) REMOVE EXISTING URINAL DRAIN FROM MAIN LEVEL, BACK TO 4" HORIZONTAL DRAIN IN CEILING OF LOWER LEVEL.
- (13) REMOVE A PORTION OF THE EXISTING 4" HORIZONTAL DRAIN IN THE CEILING OF LOWER LEVEL TO PROVIDE SPACE FOR A NEW 3" WC BRANCH. A NEW CHILD'S WC WILL BE INSTALLED AT THE ORIGINAL URINAL LOCATION ON MAIN LEVEL.
- (14) EXISTING 1/2" CW SUPPLY UP TO WC TO BE REUSED FOR NEW CHILD'S TOILET.
- (15) EXISTING WC BRANCH TO REMAIN. BRANCH WILL BE REUSED WITH NEW WC.
- (16) NEW LOWER LEVEL RESTROOMS ARE SUBSTANTIALLY SHORTER IN THE EAST TO WEST DIRECTION, HOWEVER, THE EXISTING EAST TOILETS LOCATIONS WILL BE RETAINED, AND REUSED. NEW TOILETS WILL BE INSTALLED AS PART OF THE RENOVATION PLANS. THE EXISTING FOUR LAVATORIES, AS WELL AS THE URINAL, AND WEST TOILET ARE TO BE REMOVED, AND THE PIPING WILL BE MODIFIED AS INDICATED BELOW.
- (17) SAW CUT FLOOR AND REMOVE LAVATORY IN-WALL DRAIN, VENT, WC DRAIN, AND URINAL DRAIN/VENT PIPING. REMOVE IN-WALL DOMESTIC WATER PIPING BACK TO ABOVE THE CEILING AND CAP. A NEW 4" DRAIN PIPE, AND A SINGLE VERTICAL COMBINATION FITTING FOR THE NEW BACK-2-BACK LAVATORY DRAINS WILL BE INSTALLED PER THE RENOVATION PLANS.
- (18) REMOVE EXISTING LAVS INCLUDING EXPOSED DRAINS AND WATER SUPPLIES.
- (19) REMOVE EXISTING TOILET AND URINAL . IN-WALL PIPING IS TO BE REMOVED PER KEYED NOTE 17.
- REMOVE EXISTING TOILET, AND WATER SUPPLY STOPS. A NEW TOILET WILL BE INSTALLED IN THE SAME LOCATION PER THE PLUMBING RENOVATION PLANS.

### GENERAL PLUMBING DEMOLITION NOTES

NOT ALL EXISTING PLUMBING PIPING LOCATIONS AND SIZES ARE KNOWN. REPRESENTATION OF EXISTING SYSTEMS ON THESE SHEETS ARE BASED ON ORIGINAL DESIGN DRAWINGS, AND ON OBSERVED PIPING. PLUMBING CONTRACTOR WILL NEED TO VERIFY EXISTING BUILDING PIPING LOCATIONS AS REQUIRED TO INSTALL NEW PLUMBING SYSTEMS. 2 COVER ALL OPENINGS INTO THE BUILDING FROM THE WORK AREA. INSURE DEBRIS IS REMOVED FROM THE CONSTRUCTION

- AND DEMOLITION AREA AND AIR BORN DEBRIS IS NOT ALLOWED TO TRAVEL TO THE REMAINDER OF THE BUILDING.
- 3 INSTALL TEMPORARY CAPS AT TERMINATION POINTS OF EXISTING PIPING, ETC. TO REMAIN DURING DEMOLITION PHASES.
- 4 COORDINATE WITH EXISTING SYSTEMS WHICH SHALL REMAIN IN OPERATION DURING DEMOLITION AND CONSTRUCTION PHASES
- 5 AFTER DEMOLITION; THE EXISTING WASTE, VENT, HOT AND COLD WATER PIPE SERVING EXISTING FIXTURES TO REMAIN SHALL BE RECONNECTED AND/OR REROUTED AS REQUIRED TO PROVIDE SERVICE TO THESE AND NEW FIXTURES.

# PLUMBING DEMO LEGEND

REMOVE EQUIPMENT OR FIXTURES

- REMOVE PIPING


-1.5" BUILDING WATER SUPPLY EXISTING WATER STACK UP HEATER-EXIST. CLEAN OUT UP EXISTING 3" S UNDER - INSULATED SLAB. FIELD VERIFY. EXISTING CONDENSATE FLOOR EXIST. FLOOR DRAIN (REF.) DRAIN < DRAIN UP SS SINK EXISTING MOP SINK-DRAIN UP REMOVE EXISTING WATER COOLER, P-TRAP, AND WATER PIPING IN STOPS. A NEW WATER CEILING OF COOLER IS TO BE LOWER LEVEL INSTALLED AT THIS SAME LOCATION -- SAWCU -EXIST. DRAIN FLOOR DRINKING FOUNTAIN ─EXIST. 1.25" CW 4"S STACK, AND 2"V IN CEILING \_\_\_\_\_\_\_ AND 1/2" HW UP HORIZONTAL SPACE THEN INTO RESTROOM TURNING DOWN DRAIN IN CEILING WALLS OF MAIN OF LOWER LEVEL IN PLUMBING LEVEL CHASE 

1 LOWER LEVEL PLUMBING DEMOLITION PLAN

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LOWER LEVEL PLUMBING **DEMOLITION** PLAN


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### GENERAL PLUMBING DEMOLITION NOTES

1 SEE SHEET P101.
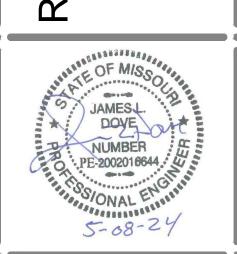
### KEYED PLUMBING DEMOLITION NOTES

- CORE-DRILL HOLES FOR THE NEW 2" DRAIN PIPE, 2" VENT, AND 1/2" INSULATED CW AND HW SUPPLIES TO NEW MAIN LEVEL SINK
- 2 REMOVE EXISTING LAVATORY DRAIN DOWN THROUGH FLOOR. REMOVE VENT TO ABOVE CEILING. REMOVE EXISTING 1/2" CW AND HW DOWN THROUGH FLOOR AND CAP IN CEILING SPACE OF LOWER LEVEL.
- REMOVE AND DISPOSE OF EXISTING PLUMBING FIXTURE. REMOVE EXPOSED DRAINS BACK TO WALL. REMOVE WATER SUPPLIES BACK TO AND INCLUDING STOPS. NEW TAILPIECES, P-TRAPS, STOPS, AND WATER SUPPLY TUBES ARE TO BE INSTALLED WITH NEW PLUMBING FIXTURES.
- THIS WC LOCATION WILL HAVE A NEW CHILD'S WC INSTALLED. REVISE DRAIN TOILET FLANGE LOCATION AS REQUIRED TO MATCH THE NEW WC ROUGH-IN.
- REMOVE EXISTING 2" VENT DOWN THROUGH FLOOR, AND UP TO ABOVE CEILING AS INDICATED. 2" VENT STACK WILL BE RE-INSTALLED AT NEW LOCATION TO FACILITATE WALL CHANGES AS INDICATED ON SHEET P104 MAIN LEVEL PLUMBING RENOVATION PLAN
- REMOVE EXISTING URINAL, AND FLUSH VALVE. DEMO EXISTING IN-WALL WATER SUPPLY BACK TO MAIN. REMOVE IN-WALL DRAIN DOWN THROUGH FLOOR AND BACK TO MAIN AS INDICATED ON SHEET P101. DEMO VENT PIPING BACK TO MAIN AND CAP. A NEW WATER CLOSET WILL BE INSTALLED AT THIS LOCATION AS INDICATED ON THE RENOVATION PLANS.
- 7 NEW 3" DRAIN STACK WILL EXTEND DOWN FROM THE CEILING AND THROUGH THE FLOOR. VERIFY THERE IS NO PLUMBING IN THE WALL AREA THAT WOULD PROHIBIT THE ROUTING OF THIS NEW PIPE AS SHOWN ON THE RENOVATION PLANS. RELOCATE ANY IN—WALL PLUMBING TO FACILITATE NEW WASTE STACK.
- (8) REMOVE EXISTING WATER CLOSET, WATER SUPPLY TUBING AND WATER STOP. NEW WC WILL BE INSTALLED AT THE SAME LOCATION WITH NEW STOPS AND SUPPLIES AS SHOWN ON THE PLUMBING RENOVATION PLANS



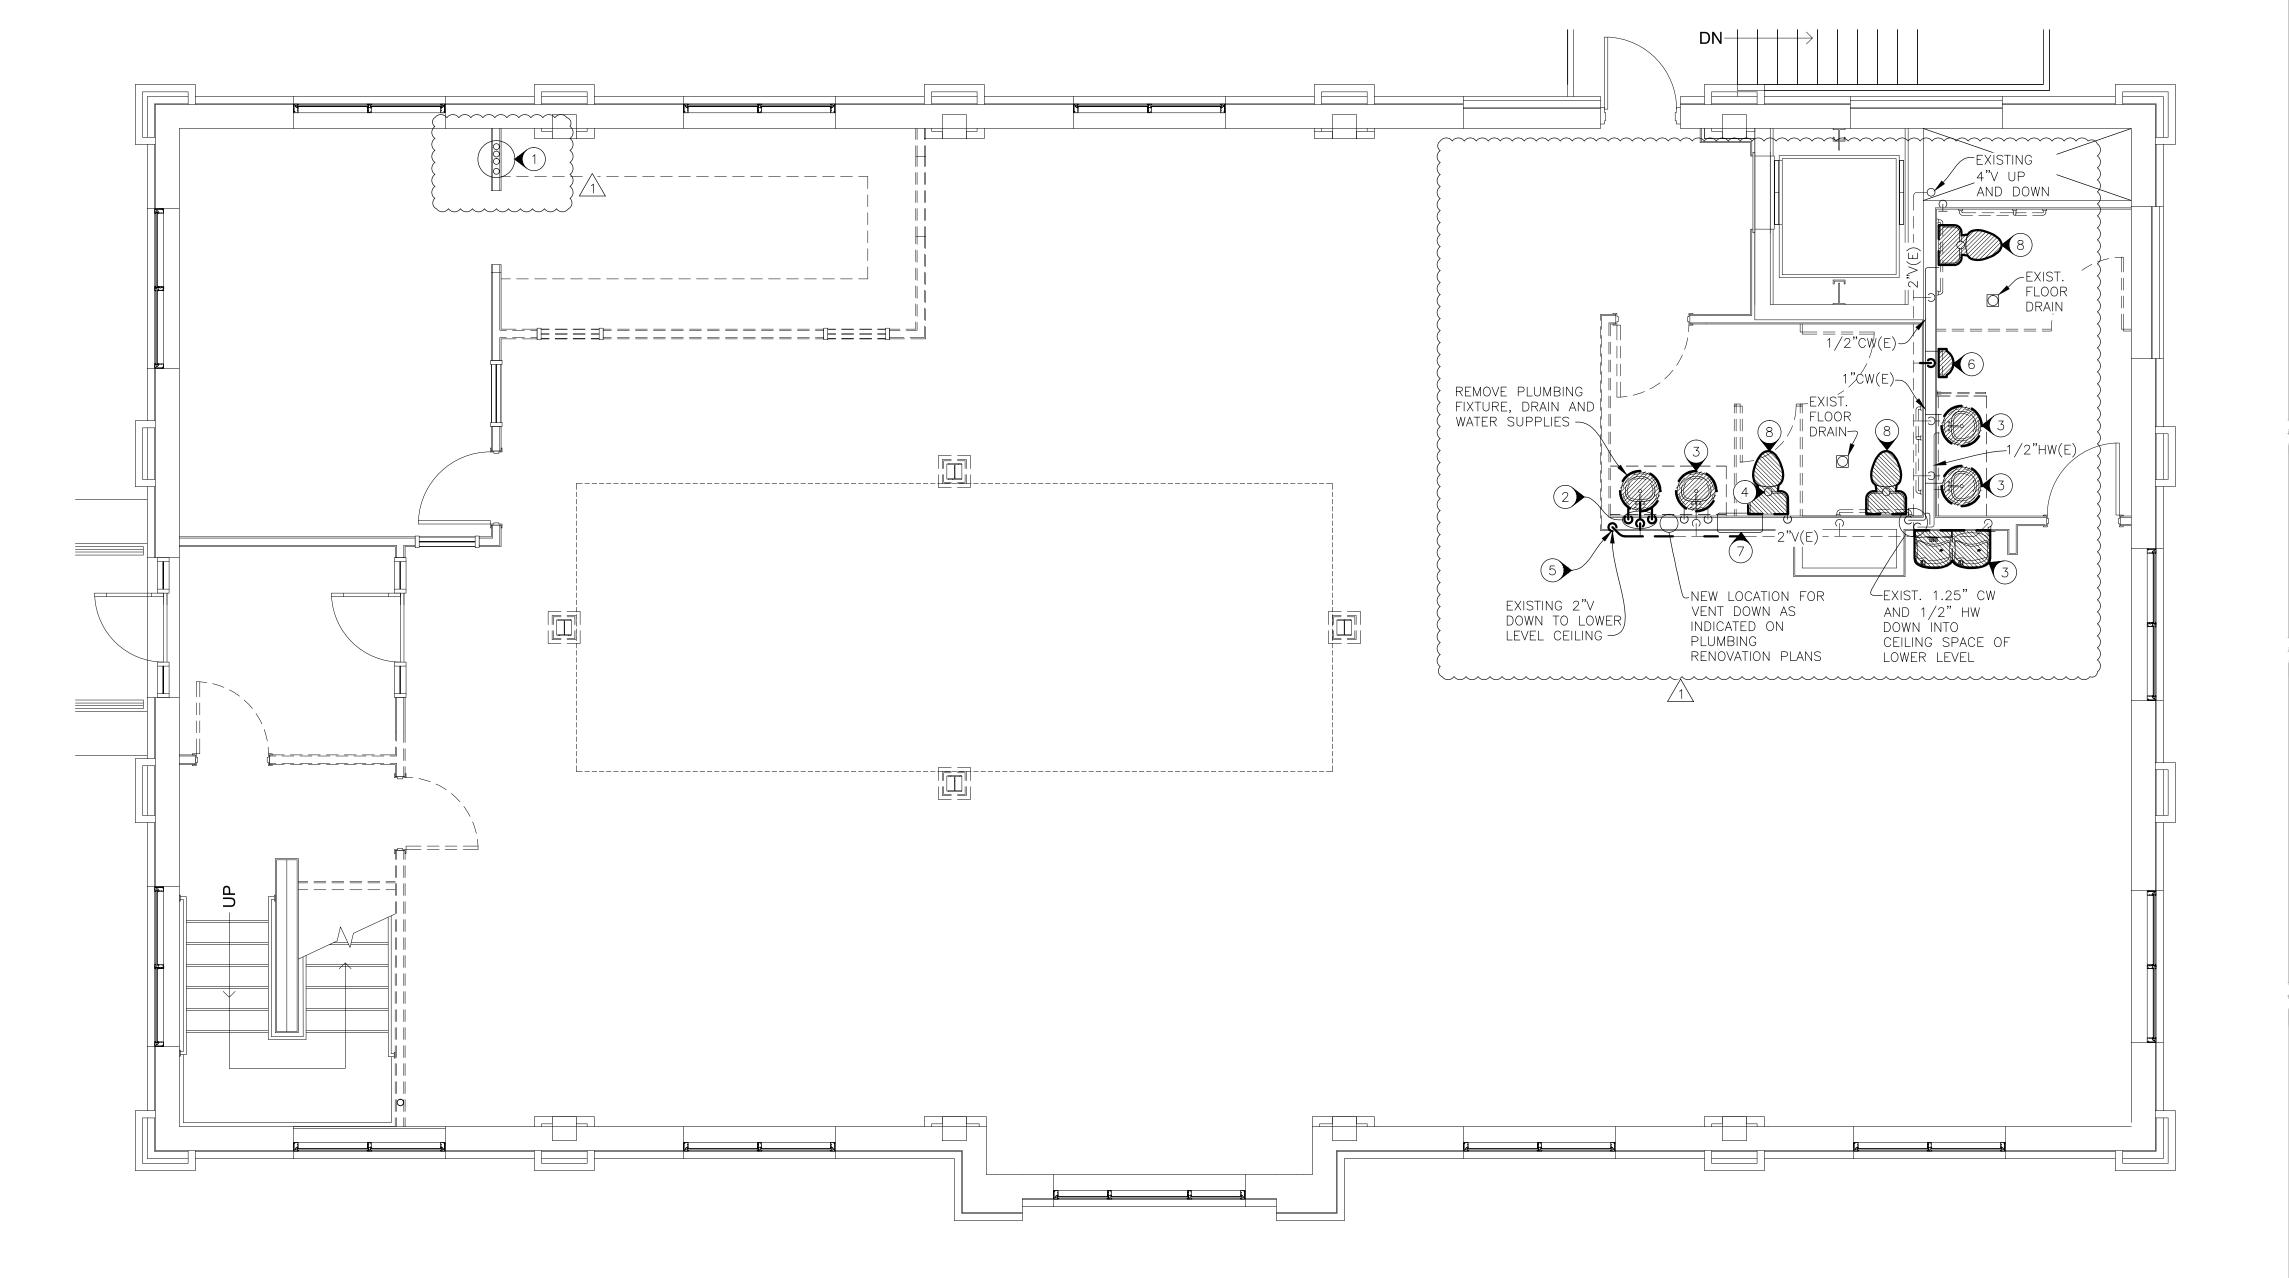




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ADDENDUM #1 05-17-2024

> Scale: 1/4" = 1'-0" MAIN LEVEL **PLUMBING** DEMOLITION

> > PLAN Date: **2024.05.03**
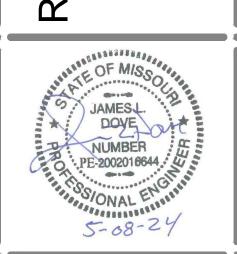
#### KEYED PLUMBING NOTES

- (1) 1/2" CW AND BALL VALVE FOR THE EXPANSION TANK INLET.
- (2) NEW 2"S SUBGRADE DRAIN FROM MAIN LEVEL SINK S-1. TIE NEW DRAIN INTO EXISTING 3" DRAIN
- (3) NEW 1/2" CW AND HW UP TO MAIN LEVEL SINK S-1. SEE DETAIL 7, SHEET P601.
- (4) install new BFP-1 and new 1.5" cw supply pipe from floor entrance, to existing pipe reconnection. BFP-1 WITH STRAINER, AND NEW 1.5" BALL VALVE AT ENTRANCE ARE NOT SHOW DUE TO CLARITY / CONGESTION. SEE DETAIL 7, ON SHEET P601 FOR DEMOLITION AND NEW PIPE INSTALLATION FOR BACKFLOW PREVENTER AND OTHER
- (5) EXISTING 1.5" CW BUILDING WATER ENTRANCE UP THROUGH FLOOR.
- (6) patch floor which was sawcut for installation of subgrade drain piping.
- (7) Provide New Water Stops and Drain Piping. Install New Sink S-1
- (8) CAPPED EXISTING DRAIN BRANCH AND WATER SUPPLIES FROM DEMOLISHED LAVATORY ON MAIN LEVEL.
- (9) EXISTING MAIN LEVEL LAVATORY DRAIN AND WATER SUPPLIES TO REMAIN AS IS, AND ARE TO BE REUSED WITH REPLACED LAVATORY.
- 3" WC BRANCH UP TO NEW WC-2 (CHILD'S TOILET). AS NOTED ON DEMOLITION SHEETS, CONTRACTOR SHOULD EVALUATE THE EXISTING WC ROUGH-IN LOCATION. IF THE ROUGH-IN IS NOT CORRECT FOR THE NEW WC-2. THE EXISTING WC BRANCH IS TO BE REMOVED, AND RE-INSTALLED AT THE CORRECT LOCATION.


- (11) INSTALL NEW 4" SUBGRADE DRAIN WHERE THE ORIGINAL LAVATORY, WC, AND URINAL DRAIN CONNECTIONS WERE REMOVED AS INDICATED ON THE DEMOLITION PLANS. INSTALL A NEW COMBINATION FITTING AND VERTICAL 2" DRAIN, AND VENT FOR THE NEW BACK-2-BACK LAVATORIES.
- (12) TIE INTO EXISTING URINAL WATER SUPPLY, AND EXTEND 1/2" CW DOWN TO THE LAVATORIES. TIE A NEW 1/2" HW INTO THE ABOVE CEILING HW PIPE AND EXTEND TO THE NEW LAVATORIES.
- (13) ROUTE 1/2" CW AND HW FROM ABOVE CEILING WATER PIPING TO NEW SINK S-1.


EXIST 1-1/2" UNDER GROUND

- (14) EXISTING 1/2" CW UP TO MAIN LEVEL FIXTURE.
- (15) EXISTING WC DRAIN UP TO MAIN LEVEL TOILET.
- (16) INSTALL NEW 3" DRAIN FROM NEW MAIN LEVEL WC-2 (CHILD'S TOILET) AND TIE INTO EXISTING 4" DRAIN IN THE LOWER LEVEL CEILING
- (17) EXISTING FLOOR DRAIN.

# GENERAL PLUMBING NOTES \_\_\_\_\_\_

- PLUMBING LAYOUTS ARE SCHEMATIC ONLY. THE EXACT LOCATION AND SIZE OF ALL EXISTING DOMESTIC WATER, SANITARY WASTE AND VENT PIPES HAVE NOT BEEN VERIFIED, AND SOME INDICATED PIPING IS BASED ON THE ORIGINAL DESIGN DRAWINGS. COORDINATE WITH EXISTING SYSTEMS AND PLUMBING FIXTURES WHICH ARE TO REMAIN AFTER DEMOLITION. RELOCATE AND REROUTE NEW OR EXISTING PIPE TO ACCOMMODATE A COMPLETE AND WORKING SYSTEM.
  - PIPE SIZES ARE MARKED ALONG THE LENGTH OF RUNS ON THE PLAN. IF THE PIPE SIZE CHANGES ON EITHER SIDE OF A FITTING, A REDUCER FITTING IS IMPLIED. PLUMBING PIPE LAYOUTS ARE DRAWN FOR DESIGN INTENT AND CLARITY. CONTRACTOR SHALL MINIMIZE THE NUMBER OF TURNS AND FITTINGS WHEREVER POSSIBLE WHILE MAINTAINING DESIGN
  - 3 FABRICATION, INSTALLATION AND TESTING OF ALL PLUMBING SYSTEMS SHALL BE IN ACCORDANCE WITH ALL STATE AND LOCAL PLUMBING CODES.
  - 4 COORDINATE ALL CASE WORK, MILL WORK, FREE STANDING PLUMBING FIXTURES, FLOOR, WALL FINISHES AND EQUIPMENT WITH ARCHITECTURAL DRAWINGS.
  - 5 PROVIDE SUITABLE SUPPORTS FOR STABILITY OF ALL PLUMBING FIXTURES AND PIPE.
  - 6 COORDINATE INSTALLATION OF PLUMBING SYSTEMS WITH OTHER TRADES.
  - 7 PROVIDE PROTECTIVE ADA INSULATION UNDER ALL EXPOSED LAVATORIES AND SINKS. INSULATION SHALL BE TRUE-BRO, OR EQUIVALENT MANUFACTURED ADA INSULATION, AND IS TO BE INSTALLED ON ALL EXPOSED DRAIN AND WATER SUPPLY
  - 8 ALL SENSOR FAUCETS ARE TO HAVE A THERMOSTATIC TEMPERATURE MIXING VALVE WHETHER INDICATED OR NOT.
  - 9 SEE SPECIFICATIONS FOR ADDITIONAL REQUIREMENTS BEYOND THOSE INDICATED ON THE DRAWINGS. SUBMITTALS ARE TO CONTAIN ONLY PROJECT SPECIFIC PRODUCT DATA. SUBMITTALS CONTAINING PRODUCTS NOT FOUND ON THE PROJECT WILL BE REJECTED. PIPE SUBMITTALS SHALL CONTAIN PIPE MATERIALS AND JOB SPECIFIC FITTINGS ONLY. DO NOT SUBMIT ON HANGER INFORMATION, ALLTHREAD, ANCHORS, CLIPS, NUTS, BOLTS, MASTICS, SOLDER, FLUX, PVC CEMENT, PVC PRIMER, OR FIRE CAULK/FIRE PENETRATION PRODUCTS OR DETAILS. DO NOT SUBMIT CATALOG PAGES OF FITTING DIMENSIONS. DO NOT SUBMIT CHEMICAL RESISTANCE INFORMATION, MSDS SHEETS, TOXICOLOGY, ECOLOGICAL, OR LEED INFORMATION. DO NOT SUBMIT INSTALLATION INSTRUCTIONS UNLESS SPECIFICALLY REQUESTED. ALL PROPOSED ITEMS IN SUBMITTALS SHOULD BE HIGHLIGHTED OR MARKED. SUBMITTALS THAT CONTAIN EXCESSIVE ITEMS LISTED ABOVE, OR NON-HIGHLIGHTED/MARKED ITEMS WILL BE REJECTED.
- 10 EXISTING WATER CLOSET DRAIN ROUGH-IN DIMENSION (10" OR 12") IS NOT KNOWN. CONTRACTOR SHOULD CHECK THE ROUGH-IN SIZE PRIOR TO PROVIDING SUBMITTALS. CONTRACTOR SHOULD ALSO NOTIFY ARCHITECT AND ENGINEER OF THIS SIZE FOR VERIFICATION DURING SUBMITTAL REVIEW.

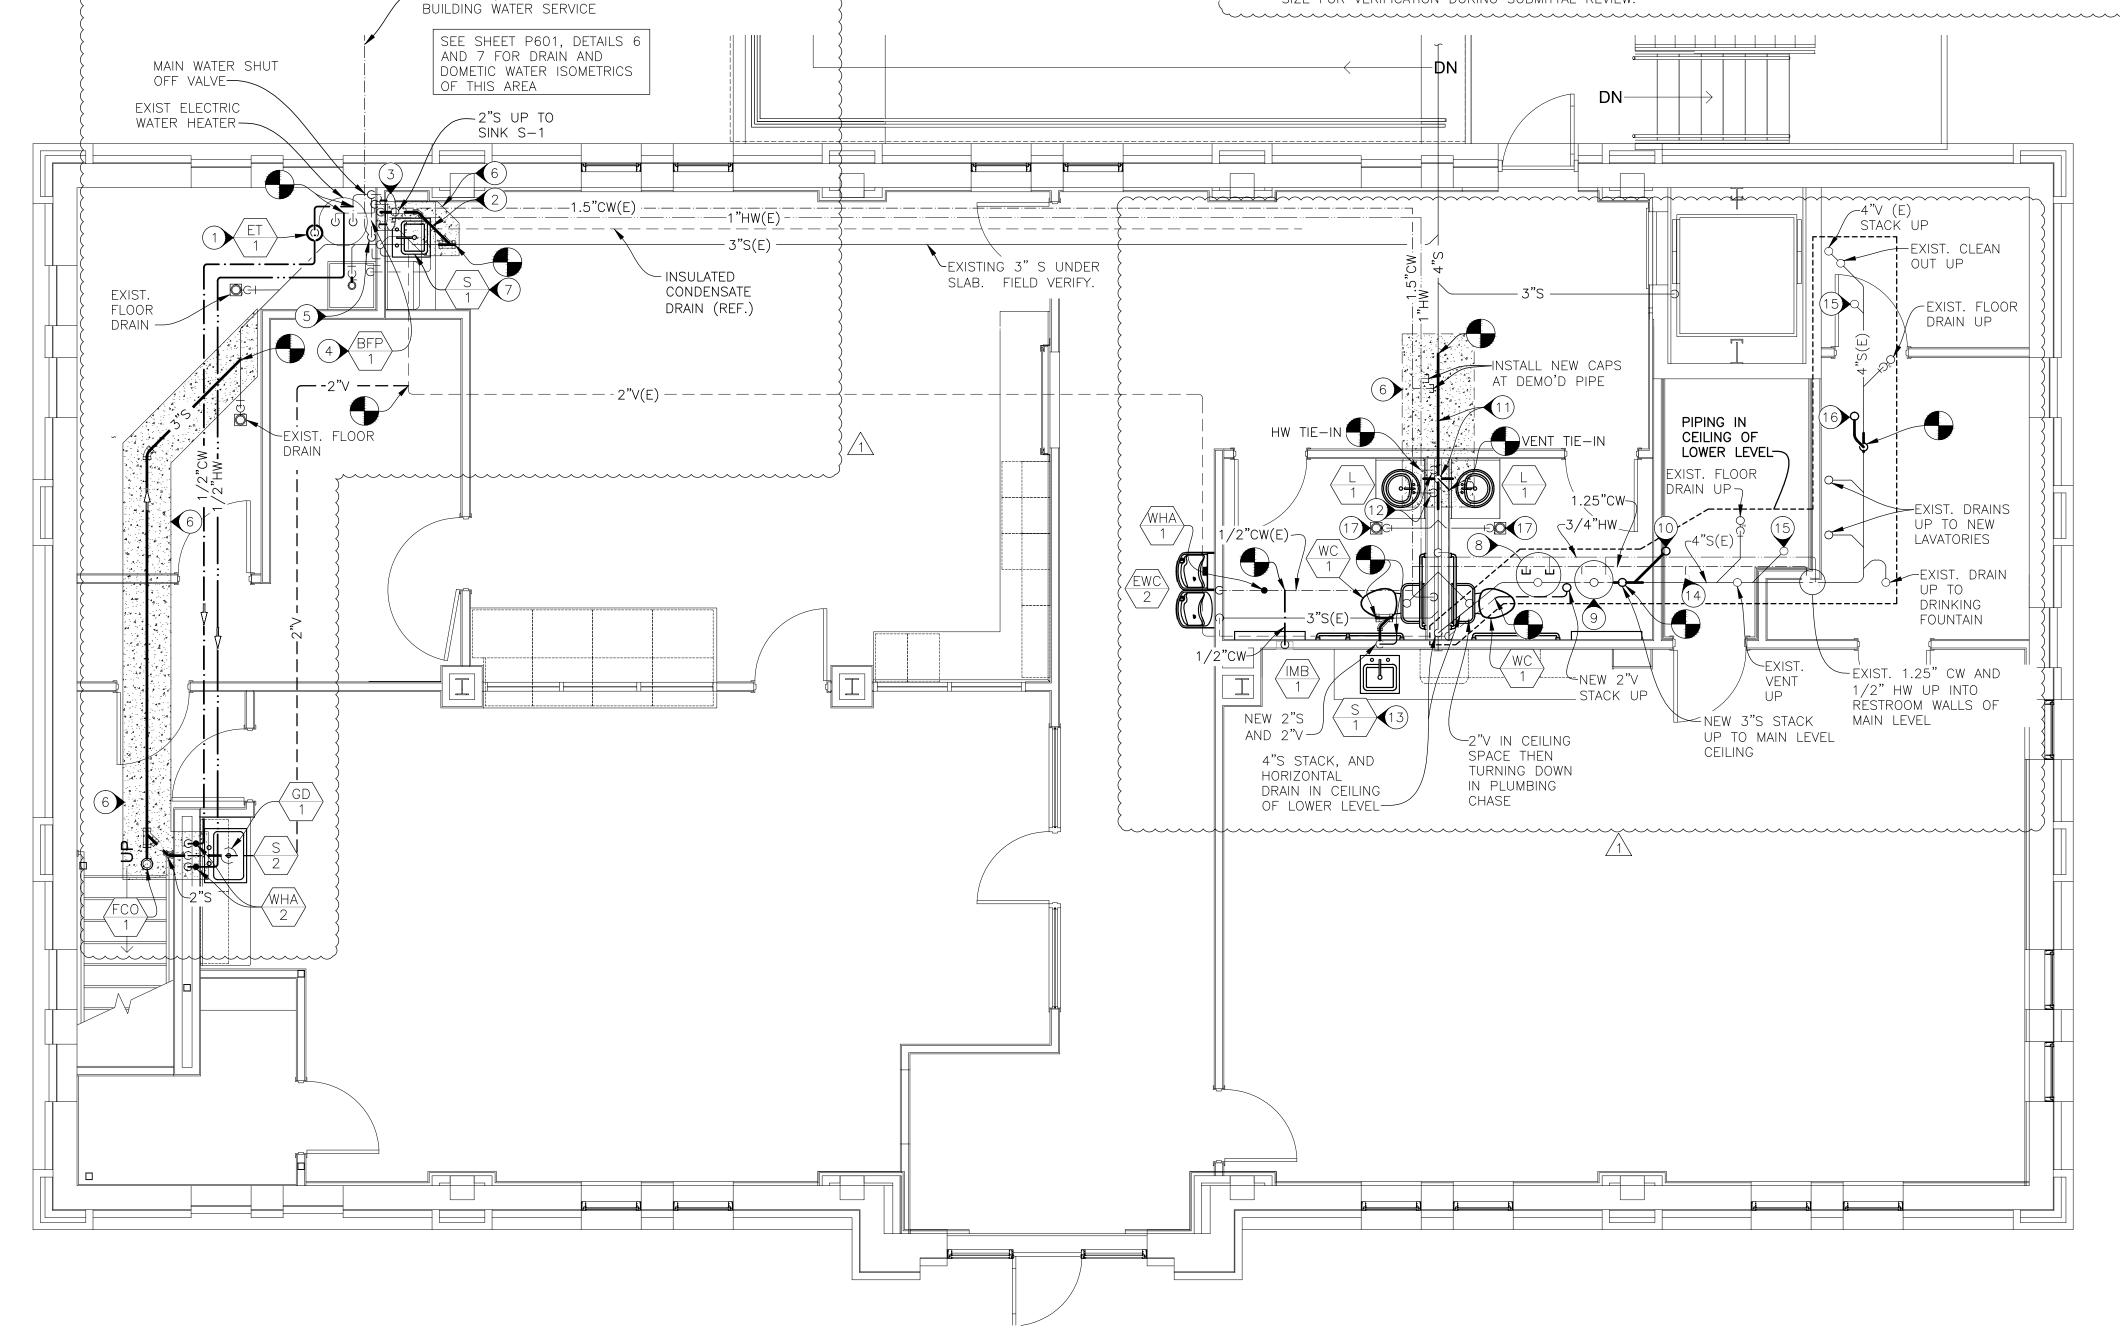

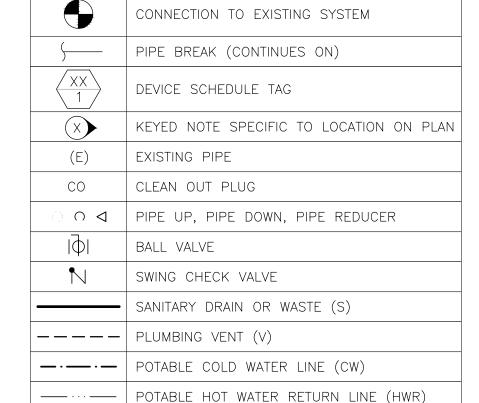

PLUMBING LEGEND

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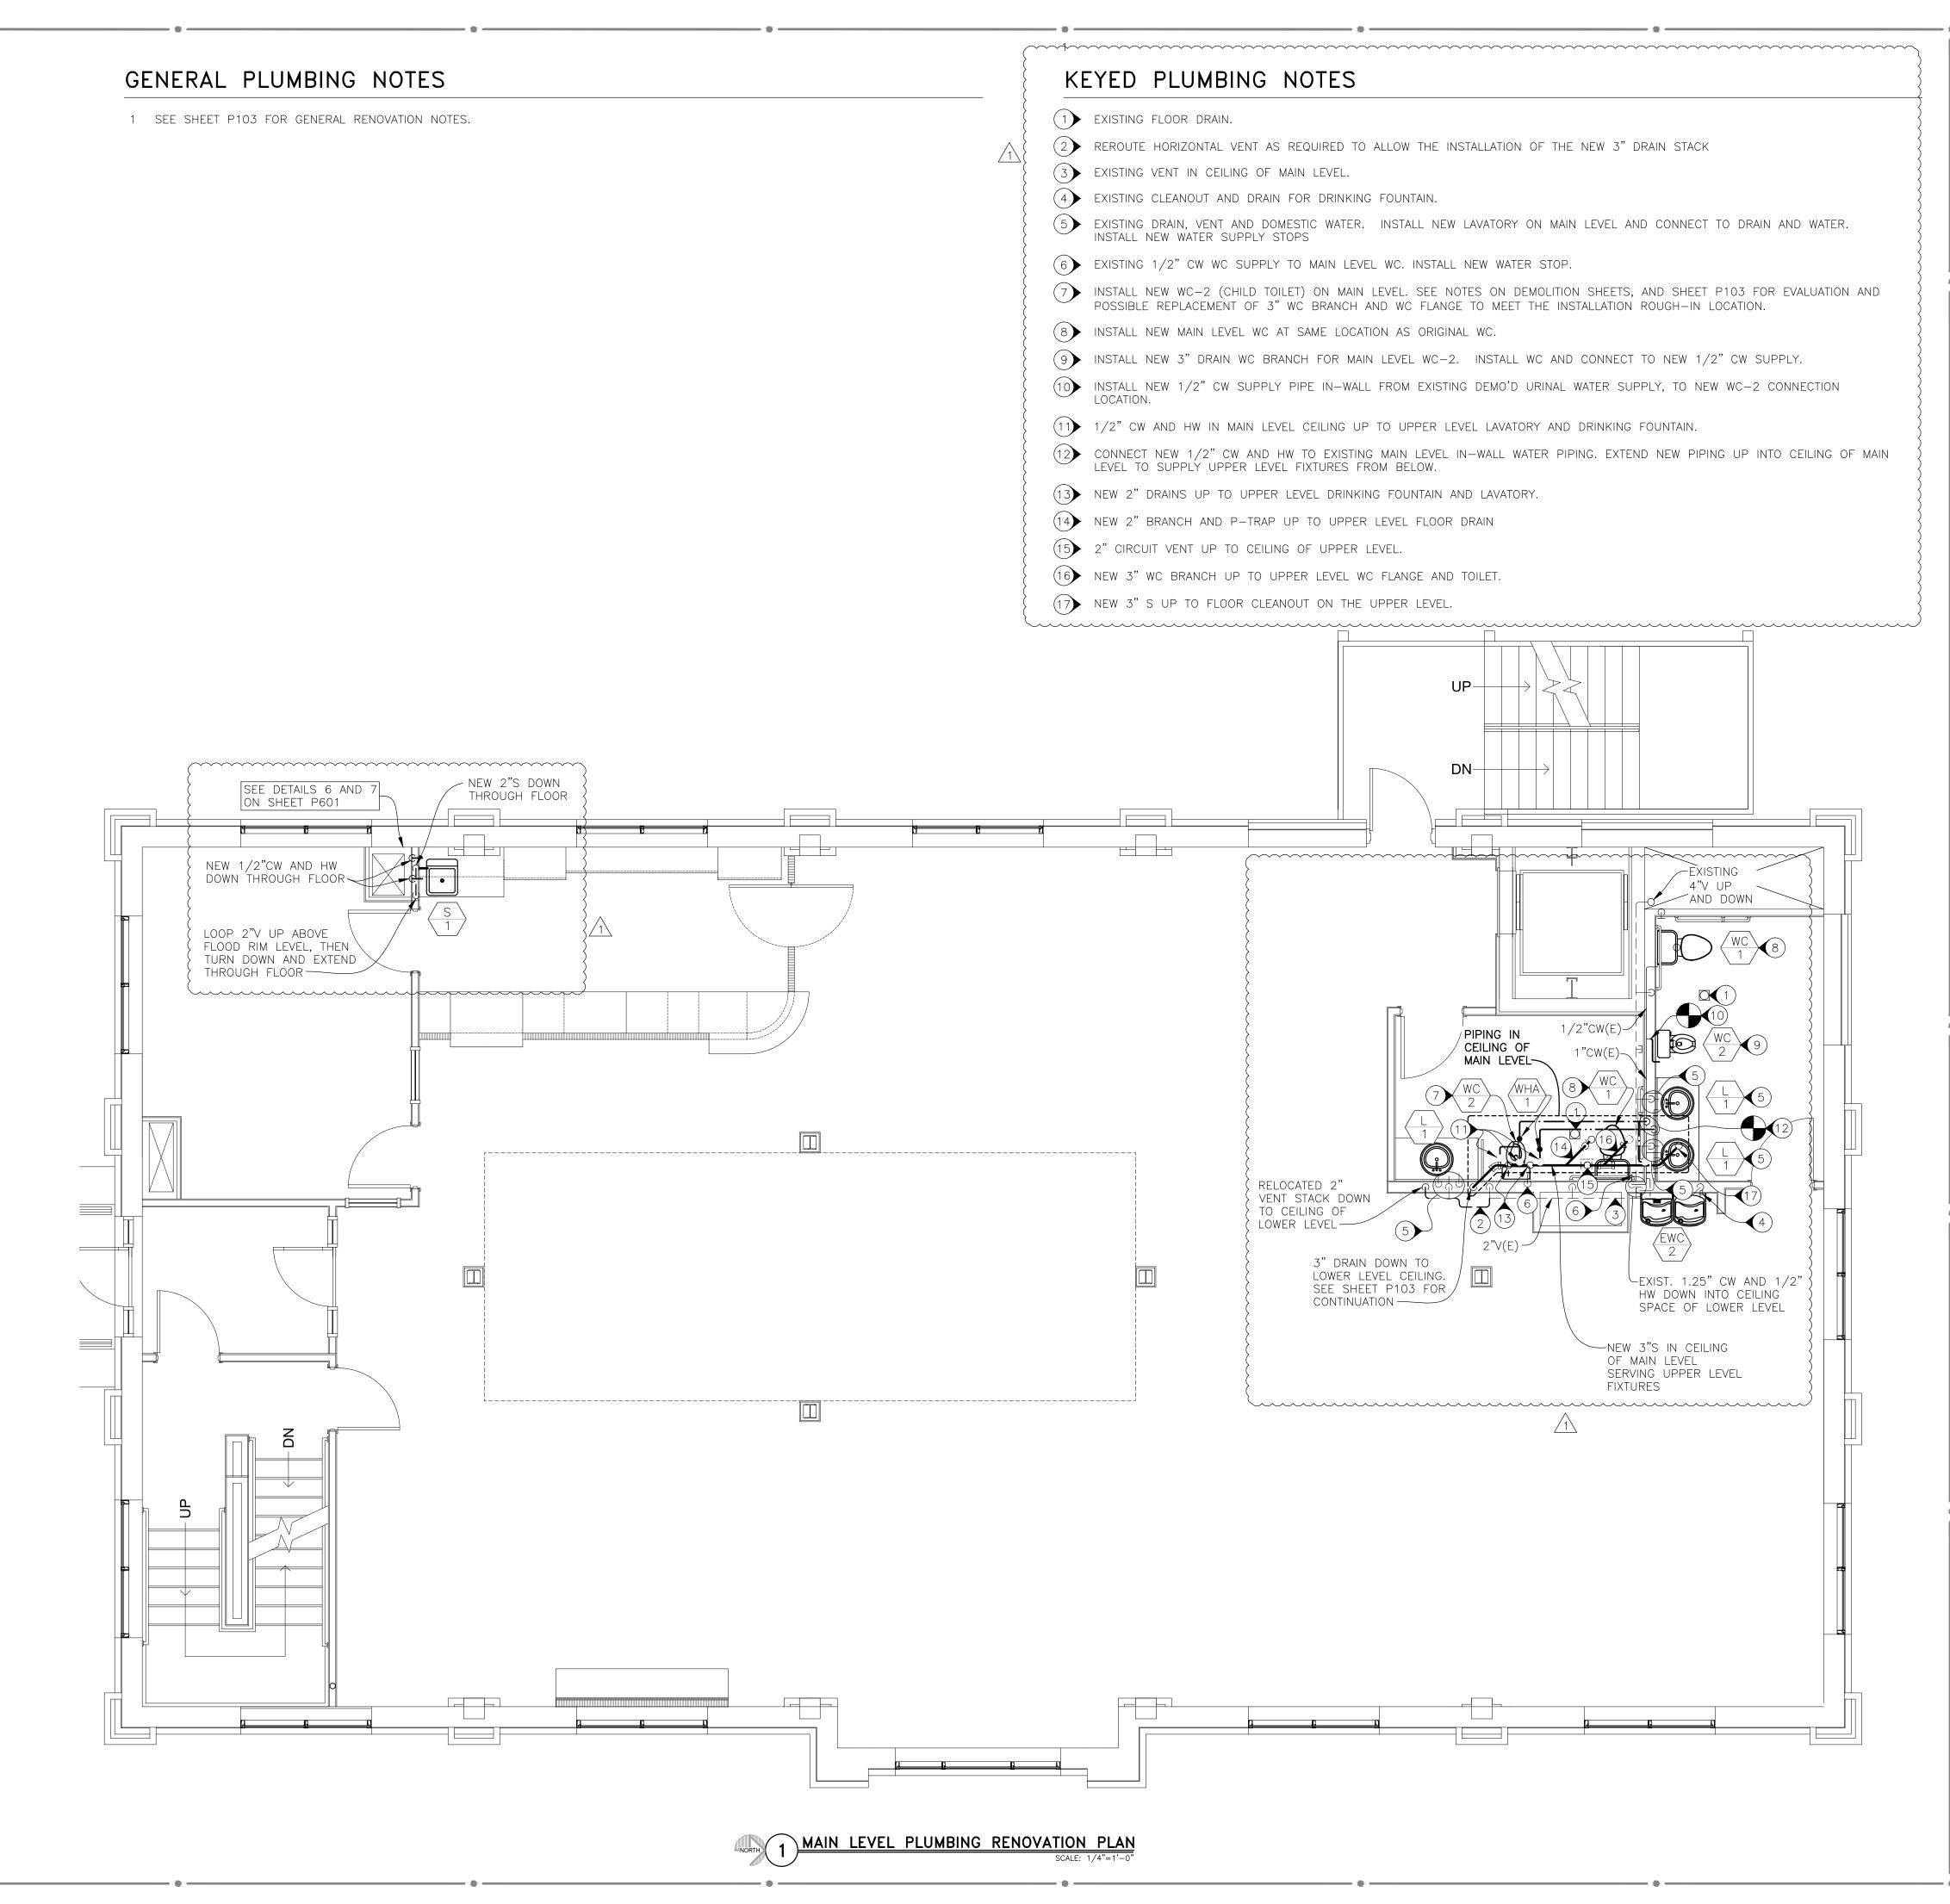
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Scale: 1/4" = 1'-0"

LOWER LEVEL PLUMBING RENOVATION PLAN


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Drawn By: GES

Checked By: JLD

Revision Date

ADDENDUM #1 05-17-2024

ADDENDUM #1 05-17-20

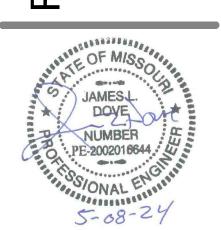MAIN LEVEL PLUMBING RENOVATION PLAN

Scale: 1/4" = 1'-0"


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P104

1 SEE SHEET P103 FOR GENERAL RENOVATION NOTES.


### KEYED PLUMBING NOTES

- 1) DRINKING FOUNTAIN 2" DRAIN DOWN THROUGH FLOOR TO MAIN LEVEL CEILING. SEE SHEET P104 FOR CONTINUATION
- (2) LAVATORY 2" DRAIN DOWN THROUGH FLOOR TO MAIN LEVEL CEILING. SEE SHEET P104 FOR CONTINUATION
- 3 2" VENT PIPE DOWN THROUGH FLOOR TO MAIN LEVEL CEILING. SEE SHEET P104 FOR CONTINUATION
- (4) WC FLANGE. SEE SEE SHEET P104 FOR CONTINUATION OF 3" WC BRANCH.
- (5) 2" FLOOR DRAIN BRANCH. SEE SEE SHEET P104 FOR CONTINUATION.
- (6) 1/2" CW SUPPLY FROM BELOW. SEE SHEET P104 FOR CONTINUATION.
- (7) 1/2" HW SUPPLY FROM BELOW. SEE SHEET P104 FOR CONTINUATION.

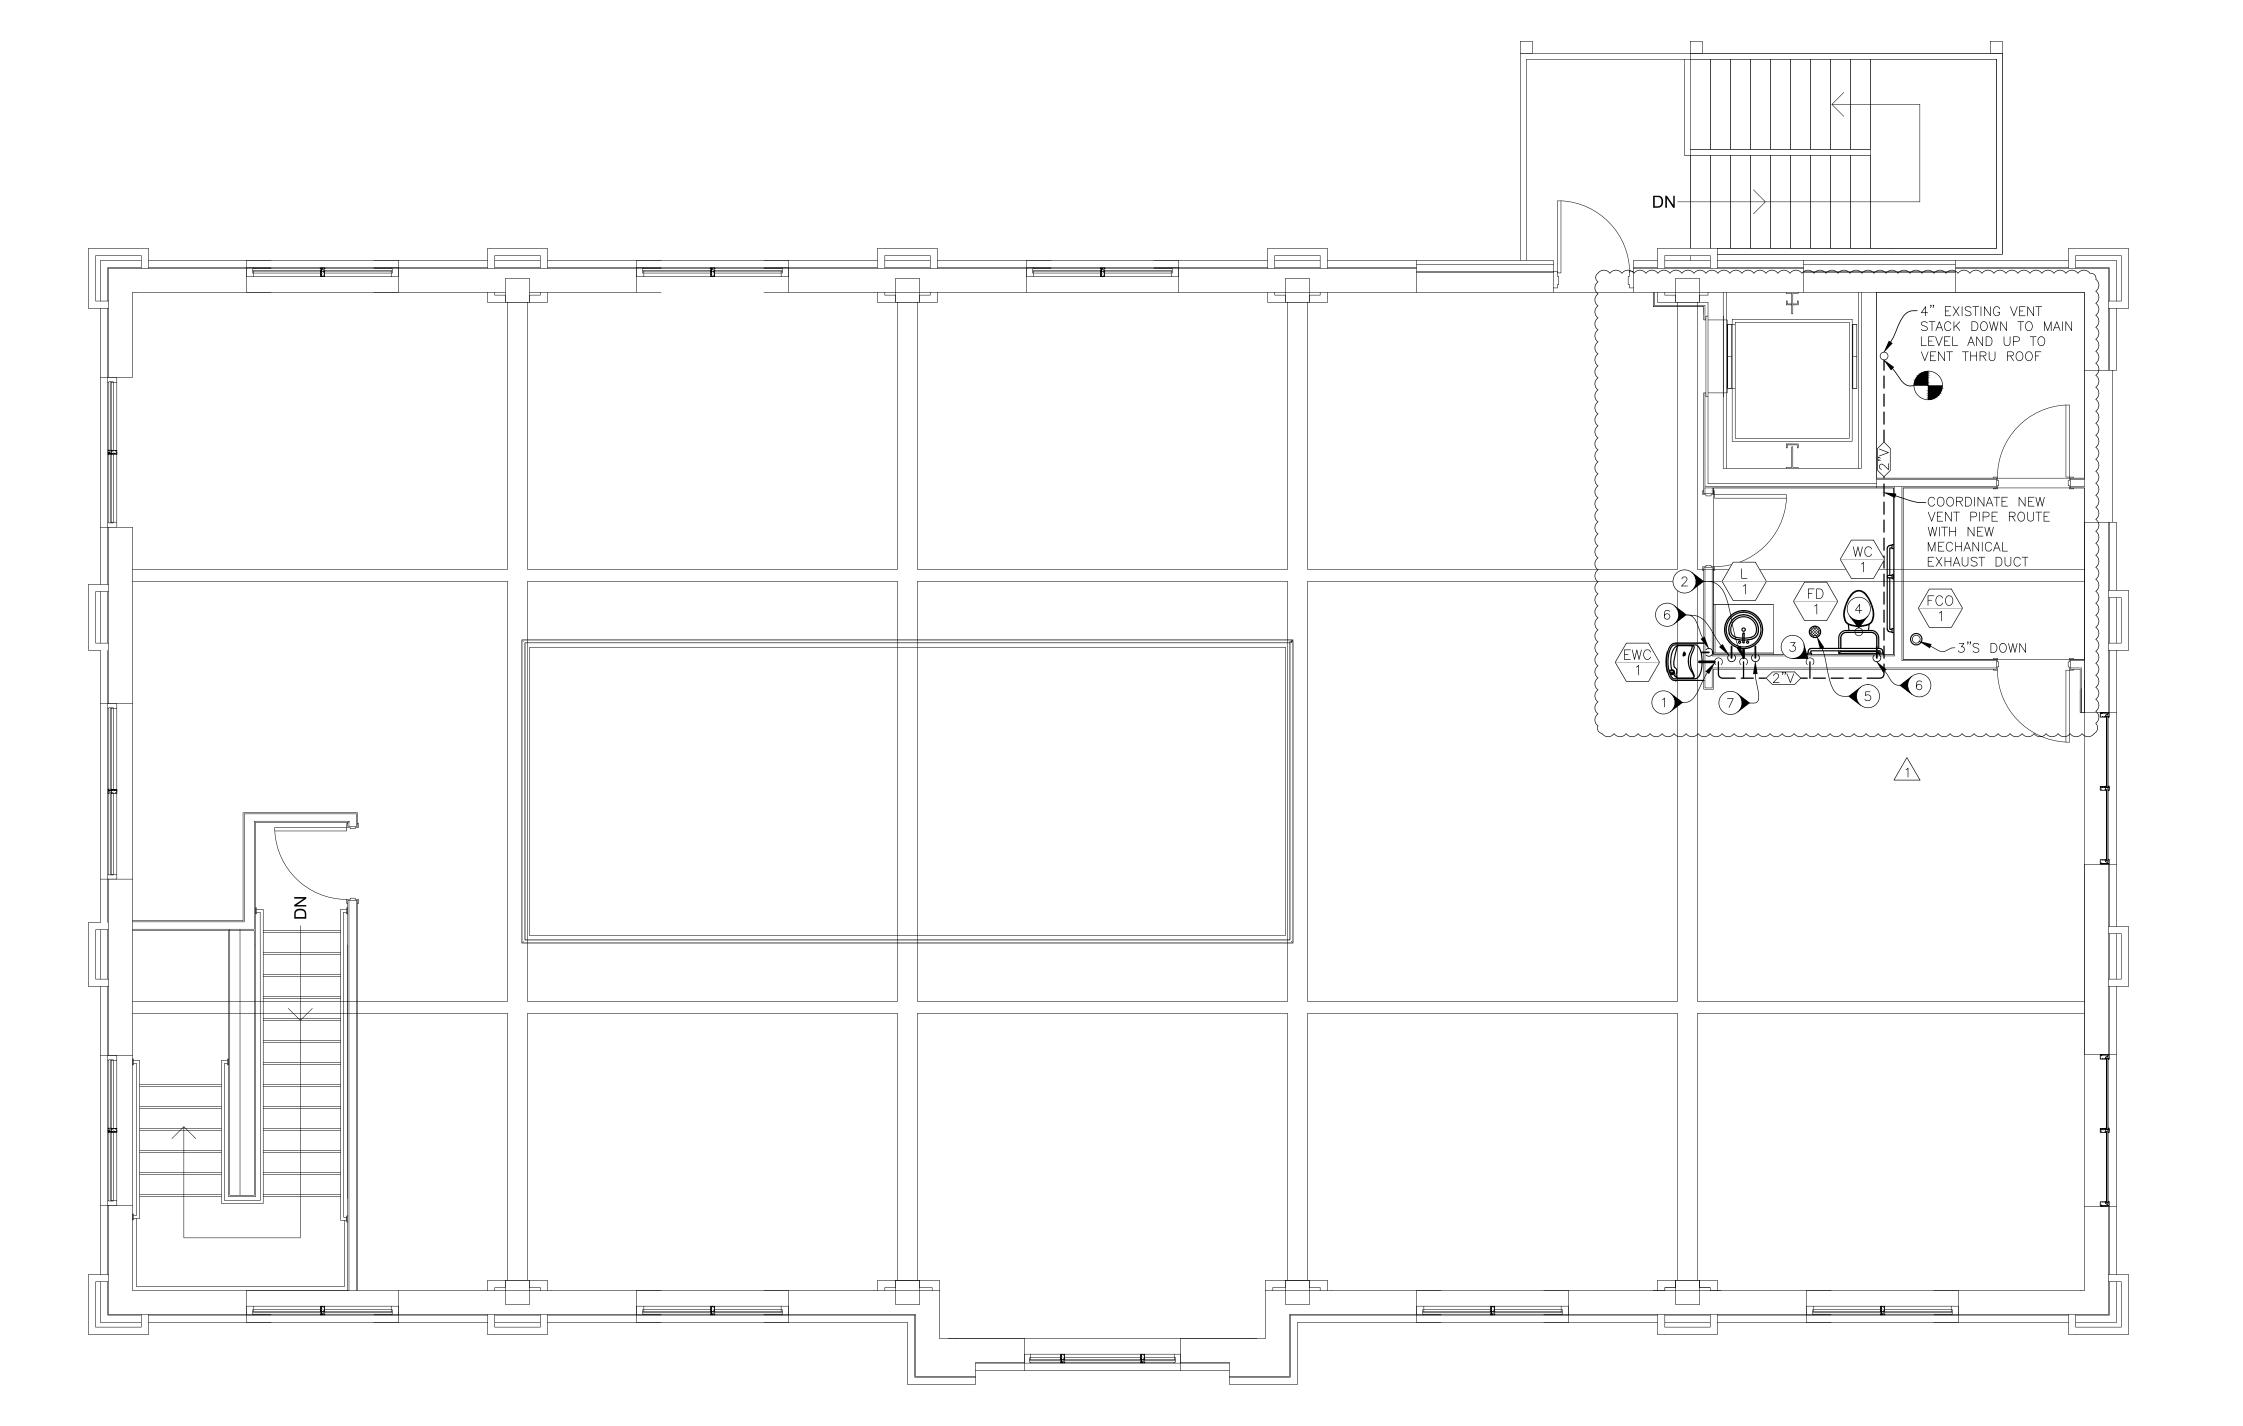

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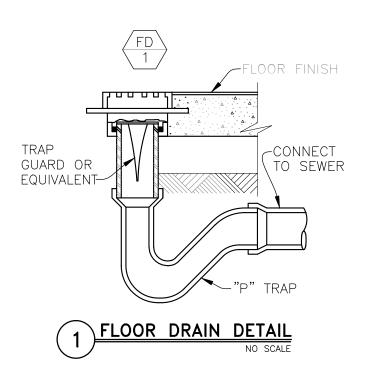
Design By: **GES** 


Drawn By: **GES** Checked By: JLD Date 05-17-2024 / ADDENDUM #1

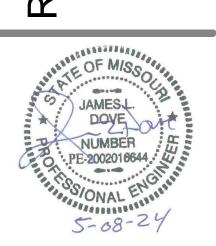
Scale: 1/4" = 1'-0"

UPPER LEVEL PLUMBING RENOVATION PLAN


Date: **2024.05.03** 




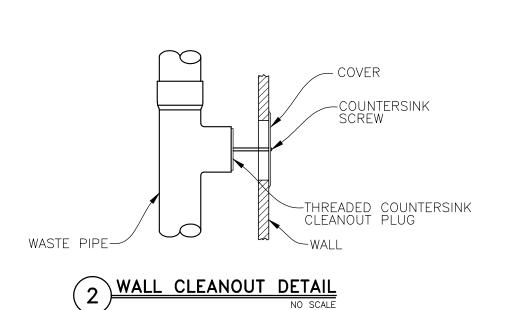

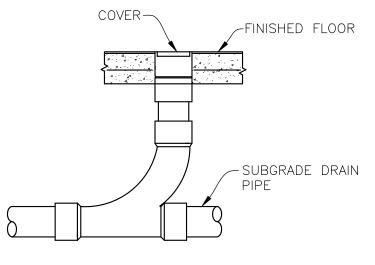




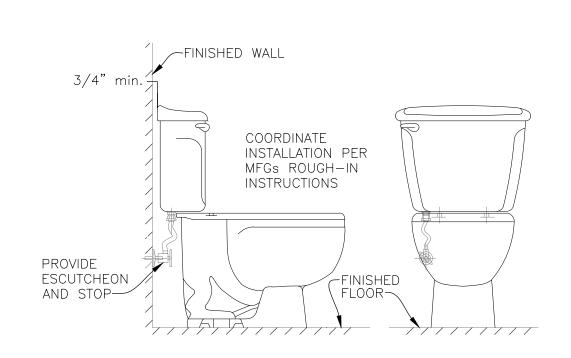

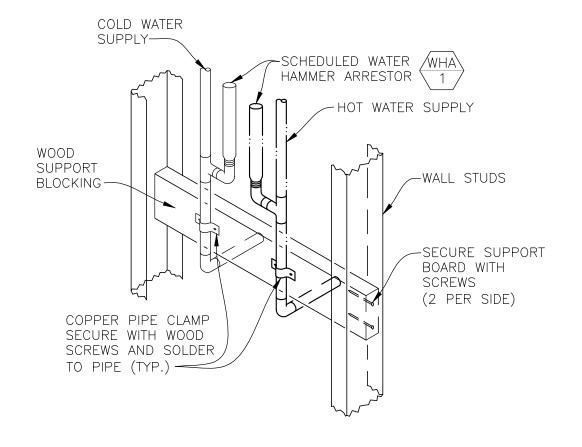

TANK TYPE TOILET DETA

5 SINK/LAV WATER ROUGH-IN DETAIL NO SCALE

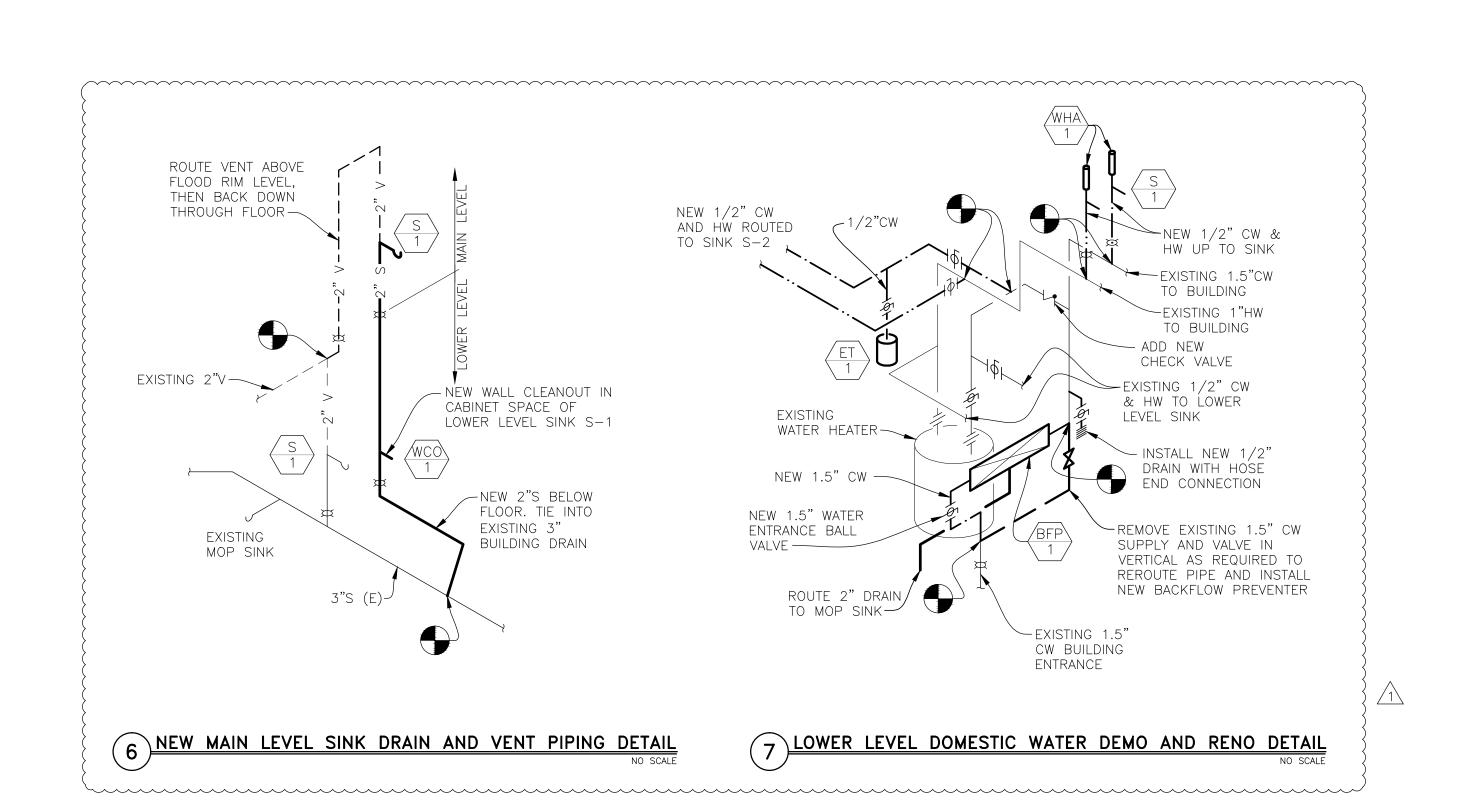

TAG	MODEL	DESCRIPTION	CONNECTIONS	REMARK	NOTES
/WC\	AMERICAN	PRESSURE	3 INCH WASTE	CADET CHAIR HEIGHT ELONGATED, 1.6 GPF	1,3
$\langle VVC \rangle$	STANDARD	ASSIST	0.5 INCH SUPPLY	SIPHON JET FLUSH ACTION	4
	2467.016	TANK TYPE		COLOR = WHITE	
/M/C	AMERICAN	WATER	3 INCH WASTE	BABY DEVORO, 10" HIGH, ELONGATED, VITREOUS	2,3
$\langle WC \rangle$	STANDARD	CLOSET	0.5 INCH SUPPLY	CHINA, 500 MAP SCORE, WHITE	4
2	2315.228	W/TANK			
NOTES					
1	AMERICAN	TOILET SEAT	SS BOLTS TO TOILET	LESS COVER, WHITE, ANTI-MORCORBIAL PROTECT	ION
ļ	STANDARD	SPLIT FRONT			
	5321.110	ELONGATED			
	AMERICAN	TOILET SEAT	SS BOLTS TO TOILET	LESS COVER, WHITE, ANTI-MORCORBIAL PROTECT	ION
2	STANDARD	SPLIT FRONT		BABY DEVORO SEAT	
	5001G.005	ELONGATED			
3	PROVIDE: CL	OSET BOLTS, WA	X RING, BRAIDED SUPPL	Y, 1/4 TURN STOP VALVE	
4	SEE PLUMBIN	NG GENERAL NO	TES FOR SPECIFIC REQUI	REMENTS FOR WATER STOPS	

	LAVATORY SCHEDULE					
TAG	MODEL	DESCRIPTION	CONNECTIONS	REMARK	NOTES	
	Z-5220	LAVATORY,	1.25 INCH WASTE	MFG: ZURN	1,2,3	
$\left\langle \begin{array}{c} L \\ 1 \end{array} \right\rangle$		UNDERMOUNT		FRONT OVERFLOW	4,5	
		19"X16"		5" DEEP		
NOTES						
1	AMTC	SENSOR	0.5" MIXED TEMP	LAVATORY FAUCET: BATTERY P	OWERED IR SENSOR	
I	AEF-301	FAUCET	3 HOLE MOUNT	SOLID BRASS SPOUT, WITH TE	IMPERATURE MIXING VALVE	
	-SH10-TMX		4" CENTERS	1 GPM AERATOR		
2	ALL FAUCET S	SUBSTITUTIONS	SHALL REQUIRE CERAMIC	DISC CARTRIDGES		
3	PROVIDE: Z8	3743 DRAIN, Z8	400-PC PTRAP, W/CLEA	N-OUT		
4	ZURN	PIPE	PVC STRAP	COMBINATION KIT: (1) TRAP, (	(2) STOP SUPPLY	
	Z8946-3	PROTECTOR		PROTECTORS AND (1) OFFSET	DRAIN PROTECTOR	
5	SEE PLUMBIN	G GENERAL NO	TES FOR SPECIFIC REQU	IREMENTS FOR WATER STOPS		

	SINK S	CHEDUL	_E		
TAG	MODEL	DESCRIPTION	CONNECTIONS	REMARK	NOTES
	ELKAY	18 GA.	22.5"W ×18.5"L OVERALL	POLISHED SATIN 304 STAINLESS STEEL	1,2,
$\left  \begin{array}{c} \left\langle \begin{array}{c} S \\ 1 \end{array} \right\rangle \right $	ECTRU21179T	SINGLE BOWL	9" DEEP	FULL SPRAY SIDES AND BOTTOM WITH SIDE AND	3
	UNDERMOUNT	SINK		BOTTOM PADS	
	ELKAY	18 GA.	27"W X 22"L OVERALL	SATIN, 304 STAINLESS STEEL,	1,2,
$\left\langle \begin{array}{c} S \\ 2 \end{array} \right\rangle$	LSR2722	SINGLE BOWL	8" DEEP	SIDE AND BOTTOM PADS	3
	UNDERMOUNT	SINK			
NOTES					
4	MOEN	HIGH ARC	0.5 INCH COLD/HOT	CHROME FINISH, 1.5 GPM, DURALAST CARTRIDGE	
	SLEEK	1-HANDLE	WATER		
	7864	PULLDOWN	1-HOLE MOUNTING		
2	PROVIDE: Z8	743 DRAIN, Z8	400-PC PTRAP, W/CLEAN	-OUT	
3	SEE PLUMBING	G GENERAL NOT	TES FOR SPECIFIC REQUIR	EMENTS FOR WATER STOPS	

	GARBAGE DISPOSAL SCHEDULE				
TAG	MODEL	DESCRIPTION	MOTOR	REMARKS	NOTES
GD 1	INSINKERATOR BADGER 1	GARBAGE DISPOSAL	1/3 HP, 120 V	PROVIDE WITH POWER CORD AND PLUG	

	VALVE SCHEDULE				
TAG	MODEL	DESCRIPTION	CONNECTIONS	REMARK	
/BFP\	WATTS	RPZ TYPE	1.25" SIZE	LEAD FREE CONSTRUCTION	
$\langle BFP \rangle$	LF009-QT	BACKFLOW	45 GPM	QUARTER TURN BALL VALVES AND UNION CONNECTIONS	
	-S-U	PREVENTER		PROVIDE WITH STRAINER AND AIR GAP FITTING	
(IMP)	SIOUX CHIEF	VALVE,	0.5" MPT-FSWT	VALVE: ICE MAKER OUTLET BOX WITH BALL VALVE	
$\langle IMB \rangle$	696-1010MF	ICE MAKER		AND AIR CUSHION HAMMER ARRESTER.	
		OUTLET BOX			
(A/I LA)	SIOUX	WATER	VARIOUS	WATER HAMMER ARRESTOR (AIR CUSHION)	
WHA	CHIEF	HAMMER	1/2"-2" SWEAT	,	
	652-AS	ARRESTER	,		
NOTES					
1	BACKFLOW PR	REVENTER ASSE	MBLIES ARE REQUIRED TO	BE NSF 61/NSF 372 LEAD CONTENT COMPLIANT	


	DRAIN	WASTE	AND VENT	SCHEDULE	
TAG	MODEL	DESCRIPTION	CONNECTIONS	REMARKS N	OTES
FD 1		CAST IRON FLOOR DRAIN	SEE PLANS FOR PIPE SIZE	PROVIDE WITH NO—HUB CONNECTION ROUND NICKEL—BRONZE STRAINER TOP	1
WCO 1	JAY R SMITH 4472T	WALL C.O. PLUG AND S.S. COVER		ROUND STAINLESS STEEL WALL ACCESS COVER WIT SECURING SCREW AND BRONZE SLOT PLUG	ΤΗ
FCO 1	JAY R SMITH 4020S	FLOOR CLEANOUT	SEE PLANS FOR PIPE SIZE	CAST IRON BODY, NICKEL BRONZE TOP (ROUND). NO—HUB CONNECTION, ABS PLUG, CAST IRON BOD FLANGE AS REQUIRED	ΟΥ
NOTES					
1	PROVIDE WITH	I PROVENT TRA	P GUARD, OR EQUIVALE	ENT	

	DRINKING FOUNTAIN SCHEDULE						
TAG	MODEL	DESCRIPTION	CONNECTIONS	REMARK			
/EWC\	ELKAY	SINGLE	1.25" SCH.40 WASTE	DRINKING FOUNTAIN, SINGLE STATION			
$\langle EWC \rangle$	LZS8L	WATER	3/8" COLD WATER	LIGHT GREY GRANITE FINISH, 8 GPH, FLA=5, 120VAC			
		COOLER		370 WATTS, PROVIDE WITH 1 REPLACEMENT FILTER			
(FW)	ELKAY	HI/LO	1.25" SCH.40 WASTE	DRINKING FOUNTAIN, TWO STATION WITH BOTTLE FILLER			
(EWC)	LZSTL8WSLP	WATER	3/8" COLD WATER	LIGHT GREY GRANITE FINISH, 8 GPH, FLA=5, 120VAC			
2		COOLER	,	370 WATTS, PROVIDE WITH 1 REPLACEMENT FILTER			
NOTES							
1	SEE PLUMBIN	G GENERAL NO	TES FOR SPECIFIC REQU	IREMENTS FOR WATER STOPS			
2	PROVIDE WITH	H IN-WALL CAR	RIER				

	EXPAN	SION TA	NK SCHED	ULE	
TAG	MFG/MODEL	DESCRIPTION	CONNECTIONS	REMARKS	NOTES
ET 1	WATTS PLT-5	TANK EXPANSION	3/4" NPT	TANK: EXPANSION. POTABLE WATER, POLYPROPYL LINER, FLEXIBLE BUTYL DIAPHRAGM, ADJUSTABLE, PRE-CHARGED. 50 GALLON MAX	

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Missouri State Certificate of Authority #2010032467

Renovations of the Library on Kemper Campu BOONSLICK REGIONAL LIBRARY 707 THIRD STREET BOONVILLE, COOPER COUNTY, MISSOURI 65233

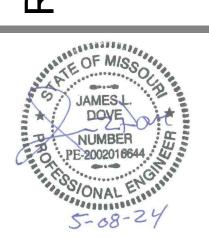

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Design By: GES

Drawn By: GES

Checked By: JLD

Revision Date No.

ADDENDUM #1 05-17-2024 1

Scale: VARIES

PLUMBING SCHEDULES AND DETAILS

Date: **2024.05.03** 

P601

#### PLAN HOLDERS LIST – 05-17-2024

PROJECT: Renovations of the Library on the Kemper Campus – Boonville, MO

Bids Due: Wednesday, May 29th, 2024 - 4:00 pm, CDT

Bids will be received at the Project Location 707 Third Street - Boonville, MO 65233 Bids will be opened and read aloud at that time.

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For informational purposes only. This list is subject to change. Additional Contractors / Sub-Contractors / Suppliers not included on this list may Bid the Project. Contractors / Sub-Contractors / Suppliers included here may elect not to Bid the Project.